



US Army Corps
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Seattle District




US Army Corps
of Engineers®
Seattle District

Date: 31 MAR 2014

File No.: E-51-4-69

PL 84-99 LEVEE REHABILITATION DYKSTRA, GREEN RIVER

AUBURN, WASHINGTON

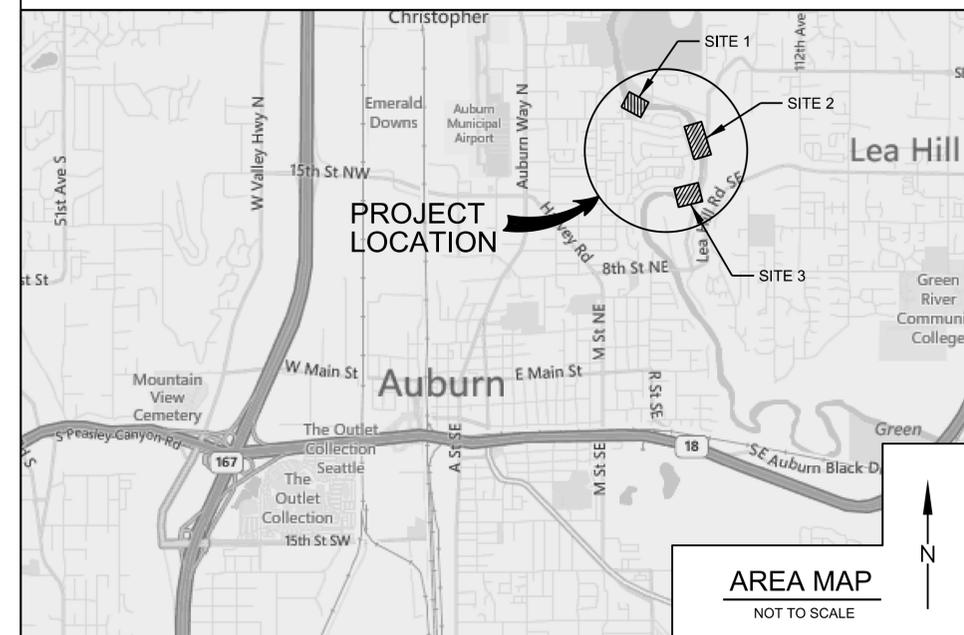

DRAWING INDEX		
SHEET NUMBER	SHEET IDEN.	TITLE
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2	C-001	LEGEND, ABBREVIATIONS, AND GENERAL NOTES
3	C-002	HAUL ROUTE AND STAGING AREA
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FY15 GRN-01-14

SAFETY PAYS

IF SHEET MEASURES LESS THAN 22" X 34" IT IS
A REDUCED PRINT. REDUCE SCALE ACCORDINGLY.

Submitted by:
LEAH WICKSTROM
Project Manager

Reviewed by:
L FORD
Tech Review

U.S. ARMY CORPS OF ENGINEERS
SEATTLE DISTRICT
SEATTLE, WASHINGTON

Prepared by:
M PEELE
Civil Section

PL 84-99 LEVEE REHABILITATION, DYKSTRA
TUKWILA, WASHINGTON

LEGEND, ABBREVIATIONS,
NOTES, AND DRAWING INDEX

SHEET
IDENTIFICATION
G-001
SHEET 1 OF 8

DESIGN FILE: I:\AEC\Designs\FY15_PN448194_GRDK\Con_Docs\CAD_Sheets\General\PN448192_GRDK-G-001\CVR.dgn
DATE AND TIME PLOTTED: 1/12/2015

D
C
B
A


1

2

3

4

5

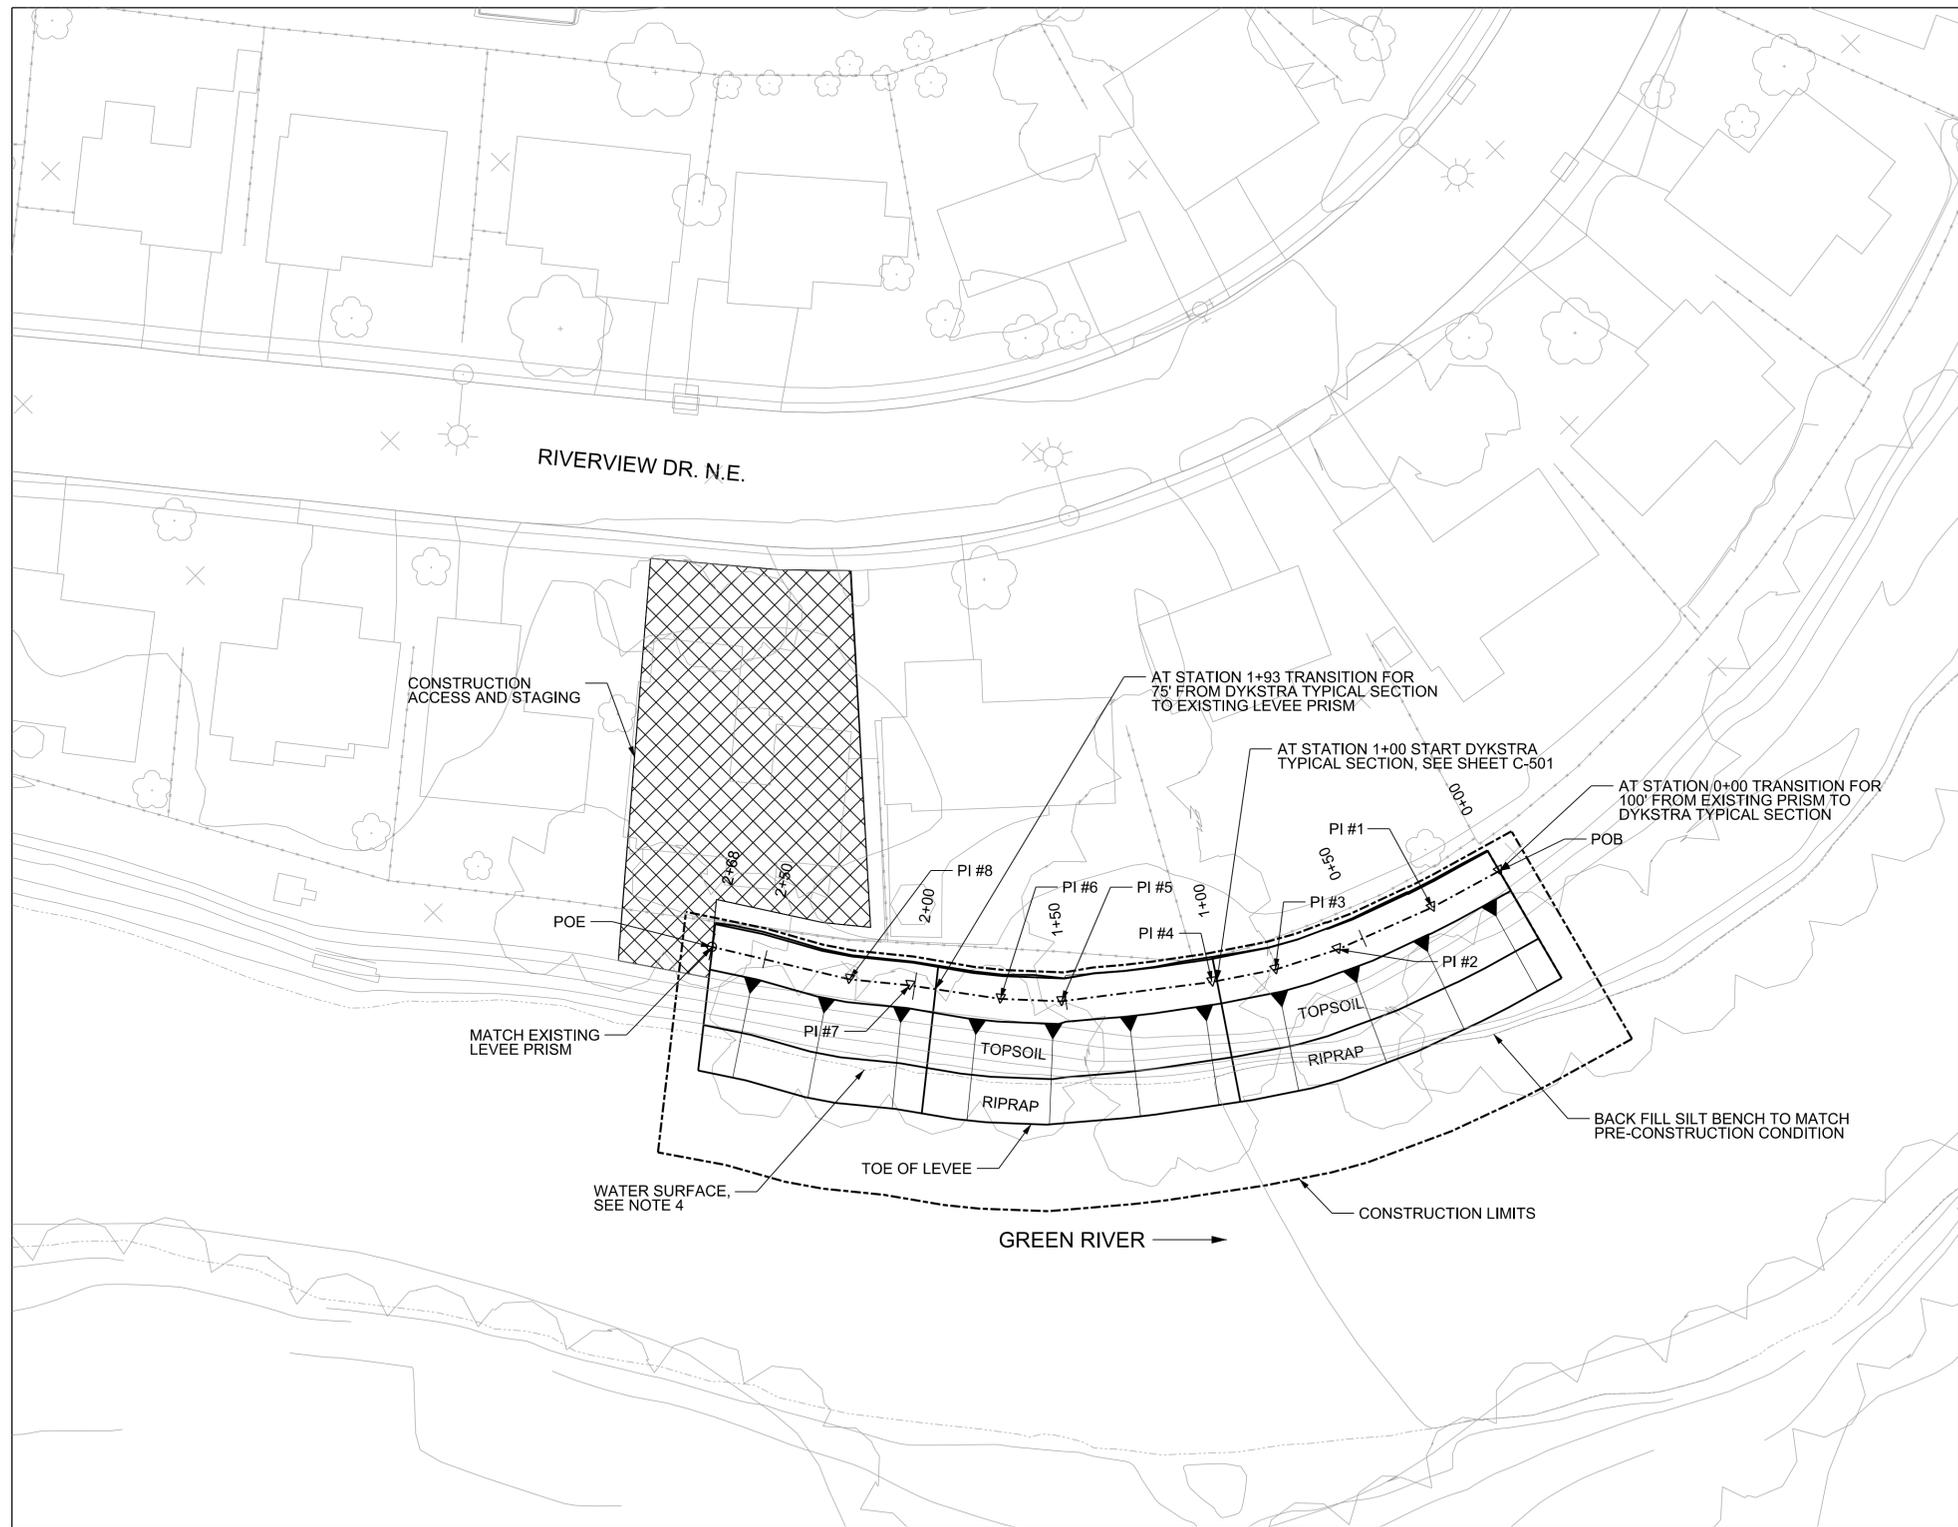

- NOTES:
- FOR LEGEND, ABBREVIATIONS, AND GENERAL NOTES, SEE SHEET C-001.
 - LEVEE TOP ELEVATION AT THE UPSTREAM AND DOWNSTREAM ENDS OF THE PROJECT SHALL MATCH THE EXISTING GRADE ELEVATIONS. A CONTINUOUS SLOPE BETWEEN THE UPSTREAM AND DOWNSTREAM END ELEVATIONS SHALL BE CONSTRUCTED FOR THE FINAL GRADE OF THE LEVEE BASED ON THE CENTERLINE OF THE LEVEE.
 - MAPPING COMPILED FROM FEBRUARY 2006 AERIAL PHOTOS. MAPPING BY 3Di WEST FOR KING COUNTY DNR AND PARKS. MAP SCALE 1"=100'. CONTOUR INTERVAL: 2 FOOT. HORIZONTAL DATUM: NAD83/91 (HARN) WA STATE PLANE NORTH ZONE (FEET), VERTICAL DATUM: NAVD 88. MAP HAS NOT BEEN COMPREHENSIVELY VERIFIED BY FIELD CHECKS.
 - TOPOGRAPHY AND CONTOURS NOT SHOWN BELOW WATER SURFACE. DUE TO SURVEY DATA BEING TAKEN FROM LIDAR DATA NO TOPOGRAPHY INFORMATION IS AVAILABLE BELOW THE WATER SURFACE.

TABLE #3 - HORIZONTAL CONTROL TABLE

POINT/TYPE	STATION/DISTANCE	DIRECTION	NORTHING	EASTING
POB	0+00.00 25.01	S 61°33'37" W	120,164.740	1,300,438.810
PI	0+25.01 33.93	S 66°07'04" W	120,152.830	1,300,416.810
PI	0+58.94 21.54	S 72°06'21" W	120,139.090	1,300,385.790
PI	0+80.48 21.16	S 79°00'18" W	120,132.470	1,300,365.290
PI	1+01.64 49.81	S 82°41'44" W	120,128.440	1,300,344.520
PI	1+51.46 20.06	N 87°43'51" W	120,122.100	1,300,295.110
PI	1+71.52 30.01	N 81°33'05" W	120,122.900	1,300,275.060
PI	2+01.54 19.98	N 84°16'09" W	120,127.310	1,300,245.370
PI	2+21.51 46.35	N 76°44'24" W	120,129.300	1,300,225.490
POE	2+67.86		120,129.300	1,300,225.490

1
DYKSTRA LEVEE SITE 3
 SCALE: 1" = 30'



DESCRIPTION	DATE	APPR.	MARK

DESIGNED BY:	DATE:	FILE NUMBER:
DWN BY:		
SUBMITTED BY:		

U.S. ARMY CORPS OF ENGINEERS
 SEATTLE DISTRICT
 SEATTLE, WASHINGTON
 FY15 GREEN RIVER LEVEE REHABILITATION
 DYKSTRA LEVEE
 AUBURN, WA
 SITE PLAN SITE 3

SHEET IDENTIFICATION
C-108
 SHEET 0 OF 0

